

BOUTELOUA GRACILIS 'BLONDE

511 TOTAL ORNAMENTAL GRASSES AND PERENNIALS

AMBITION'

nep 88 NEPTA X FAASENII 'WALKERS LOW'

150 COREOPSIS LANCEOLATA

pan 38 PANICUM VIRGATUM 'NORTHWIND'

125 | HELICTOTRICHON SEMPERVIRENS

BLONDE AMBITION BLUE

WALKERS LOW CATMINT

LANCELEAF COREOPSIS

NORTHWIND SWITCHGRASS

BLUE OAT GRASS

1 GAL

1 GAL

1 GAL

1 GAL

1 GAL

30CM O.C. SPACING

60CM O.C. SPACING

60CM O.C. SPACING

45CM O.C. SPACING

1 M O.C. SPACING

TA 9 TILIA AMERICANA 'REDMOND'

21 TOTAL TREES

Am | 107 | ARONIA MELENOCARPA

20 CORNUS RACEMOSA

36 CORNUS SERICEA 'FLAVIRAMEA'

Js 48 JUNIPERUS SABINA 'TAMARISCIFOLIA'

SHRUBS

Су

REDMOND BASSWOOD

BLACK CHOKE CHERRY

YELLOWTWIG DOGWOOD

GREY DOGWOOD

TAMARIX JUNIPER

50 MM CAL

50 CM HT

50 CM HT

50 CM HT

WB

POTTED

50 CM WD POTTED 1.2M O.C. SPACING

POTTED 1 M O.C.

3 GALLON 1.5 M O.C. SPACING

10M O.C. SPACING

1.2M O.C. SPACING

## **GENERAL NOTES**

- 1. Base information sources: Site Plan dated January 13, 2022 prepare
- by Fryett Turner Architects Inc. All dimensions are in metric unless otherwise noted.
- Do not scale drawings. Dimensions are to be verified on site by
- Contractor prior to commencement of the work. 4. These plans shall be read in conjunction with all details, notes, reports, written specifications, general conditions, any supplement conditions and agreement which form the contract documents. 5. These drawings shall not be used for construction purposes unles noted as "Issued for Construction" and signed by the Landscape
- 6. Contractor shall review all drawings and verify actual field condition to determine the total scope of work and all required coordination prior to submission of bids and commencement of the work. Repo any discrepancies to the Landscape Architect, for action to the satisfaction of the Owner.
- Contractor shall locate all underground, at grade and overhead utilities prior to commencement of the work. All utilities not necessarily shown on these drawings. Aboud & Associates assum
- no responsibility for the accuracy of any utilities shown in these 8. Contractor shall perform all work in accordance with to the most current Ontario Building Code, CAN/CSA-Z614, Occupational Health
- 9. Contractor shall identify the location of all internal/external construction access routes, parking and storage of materials in conformance with project erosion and sediment control plans for acceptance by the Owner. Construction, maintenance and removal/restoration of access, parking and storage facilities shall be
- 10. Contractor shall submit shop drawings where indicated in these drawings. Shop drawings shall be certified by a Professional Engineer licensed to practice in Ontario and reviewed by the contractor for dimensional correlation with the drawings and field conditions. Fabrication of elements on shop drawings shall not proceed until drawings have been reviewed and approved by a Professional Engineer and have been accepted for general design conformance by the Landscape Architect in writing. The cost of preparing shop drawings, as well as the services of a Professional Engineer, shall be included in the Contractor's bid price.
- 11. Contractor proposed substitution of materials and products shall be submitted in writing for review by Landscape Architect and acceptance by Owner and Municipality.
- 12. Material quantities on drawings shall take precedent over those in lists and schedules.
- 13. Where traffic control is necessary, Contractor shall use the guideline of the Construction Safety Association of Ontario, municipal by-laws, the Highway Traffic Act and the Ontario Traffic Manual (Book 7). The cost of preparing, obtaining approvals and implementing traffic control plans shall be included in the Contractor's bid price, unless otherwise
- 14. Contractor shall erect temporary barriers, as required, to secure the work area. Contractor shall maintain temporary barriers in good repair and remove at the end of the work.
- 15. Contractor shall provide layout and grade staking, for general review for design conformance by Landscape Architect and acceptance by Owner. Where the work occurs within 3 metres of a property boundary, layout and staking shall be completed by an Ontario Land Surveyor. The cost of layout and grade staking, as well as the services of an Ontario Land Surveyor, shall be included in the Contractor's bid price, unless otherwise noted.
- 16. Contractor is responsible for protecting and/or reinstating site elements indicated in these drawings
- 17. Contractor is responsible for restoration of adjacent surfaces and existing site elements damaged by the Contractor in the performance of the work, including but not limited to roads, driveways, playground equipment, utilities, buildings, curbs, sidewalks, retaining walls, fencing, turf, flowers and woody vegetation. Restoration work shall be performed by the Contractor at no cost to the Owner and be completed in conformance with applicable Provincial, Municipal or Agency standards and requirements, to the satisfaction of the Owner/Agency of the damaged element.
- 18. Where new paving or earthwork meets existing, smoothly blend line and grade of existing with new.
- 19. Test existing topsoil to be reused as growing medium on site in accordance with:
- 19.1. Top Soil Basic Package (by SGS Laboratories or approved equal testing facility) Testing the following properties: Texture (%sand, %silt ,%clay), total salts, pH, buffer pH, phosphorus, potassium, magnesium, calcium, cation exchange capacity, chloride, sodium, sodium absorption ratio, organic matter.
- Written recommendations for amendments. 19.2. The cost to amend existing topsoil to be reused shall be paid for by the Owner.
- 20. Contractor shall provide imported topsoil test results (using analysis requirements for existing topoil) prior to delivery to place of work, for
- 21. Plants specified on these plans are to be in accordance with the Canadian Nursery Landscape Association Canadian Standards for Nursery Stock from the Canadian Landscape Standard, current
- Only nursery grown plants will be accepted. • Landscape Architect reserves the right to reject any plant material not in conformance with the standard, displaying life-threatening, poor growth habits, injury, disease or not true to name. Contractor shall remove rejected plants from the site immediately and replace
- at no additional cost to the Owner. 22. Proposed plants which come over or under any utility shall be relocated by the Contractor for review by the Landscape Architect,
- the satisfaction of the utility provider. 23. All work and materials are to be warrantied by the Contractor for twenty-four (24) months from date of initial acceptance of all items by Municipal Staff and Project Landscape Architect.
- these drawings for all the installed trees, shrubs, grasses and seeding during the warranty period.
- 23.2. The Owner shall provide maintenance as described in these drawings for all installed trees, shrubs, grasses and seeding during the warranty period.

MONARDA FISTULOSA

SPOROBOLUS

CRYTANDRUS

ASTER LAEVIS

SCHIZACHYRIUM

SEEDING RATE = 25 KG / HECTARE

12 RUDBECKIA HIRTA

SCOPARIUM

20

WILD BERGAMOT

SAND DROPSEED

SMOOTH BLUE ASTER

BLACK-EYED SUSAN

LITTLE BLUESTEM

oared	CHANCATE DRIVE
ntal	DRIVE LEE
ss	CHANGATE  CHANGATE  ALGONICUM DRIVE  ALGONICUM DRIVE  BIRCHWOOD DR
ons I ort	CALLONAY BOULEY ARD SOME ACON STIFF SOUTHWINDS CRESCE
nes	N.T.S. KEY MAP

LEGEND:

PROPOSED DECIDUOUS TREES



PROPOSED DECIDUOUS SHRUBS

PROPOSED CONIFEROUS SHRUBS 252588888 PROPOSED ORNAMENTAL GRASSES

PROPOSED PERENNIALS, GROUNDCOVERS, AND ANNUALS QTY SPE PLANT KEY

PROPOSED SEEDED AREA - S-1 MIX HYDRAULICALLY SEED AND USE BONDED FIBRE MATRIX AS THE COVER PER OPSS 804

PROPOSED SOD

Ψ Ψ Ψ RIVERSTONE MULCH

PROPERTY LINE

ALL SOD PLANTED ON 3:1 SLOPE TO BE STAKED

	8	RE-SUBMITTED FOR SPA	MGN	09 Nov-21
r	7	SUBMITTED FOR SITE PLAN APPROVAL	MGN	10 Aug-21
	6	SUBMITTED FOR CORRDINATION	SK	06 Aug-21
	5	SUBMITTED FOR CORRDINATION	SK	06 Apr-21
	4	SUBMITTED FOR SITE PLAN APPROVAL	MGN	24 Mar-21
	No.	Description	Ву	Date




All previous issues of this drawing are superced

LANDSCAPE PLAN

**REVISIONS:** 


786 WILLIAM ST MIDLAND ONTARIO JENNARK HOMES

Date: NOVEMBER 2020 Designer: SK Project: AA20-147A Drawn: SK Scale: 1:250 Checked: X

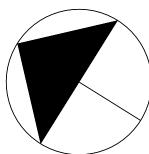


Drawing No:



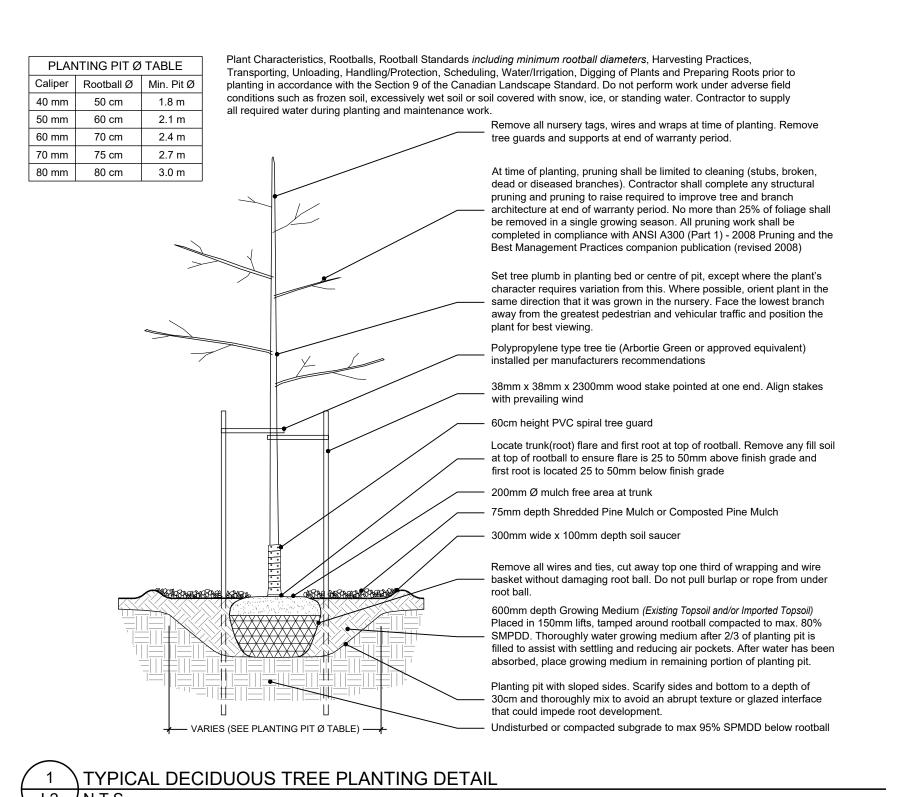


Plant Characteristics, Rootballs, Rootball Standards including minimum rootball diameters, Harvesting Practices, Transporting, Unloading, Handling/Protection, Scheduling, Water/Irrigation, Digging of Plants and Preparing Roots prior to planting in accordance with the Section 9 of the Canadian Landscape Standard. Do not perform work under adverse field conditions such as frozen soil, excessively wet soil or soil covered with snow, ice, or standing water. Contractor to supply required water, free from any organic or chemical contaminants detrimental to humans, animals or healthy plant growth,

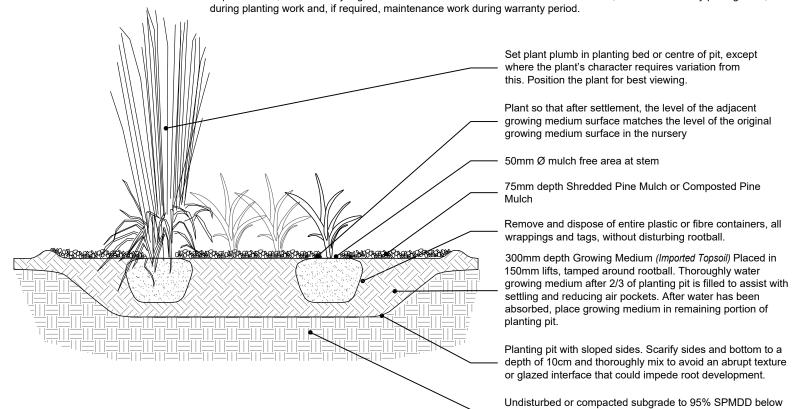


2 TYPICAL PERENNIAL PLANTING DETAIL - CONTINUOUS BED

Plant Characteristics, Rootballs, Rootball Standards including minimum rootball diameters, Harvesting Practices, Transporting, Unloading, Handling/Protection, Scheduling, Water/Irrigation, Digging of Plants and Preparing Roots prior to planting in accordance with the Section 9 of the Canadian Landscape Standard. Do not perform work under adverse field conditions such as frozen soil, excessively wet soil or soil covered with snow, ice, or standing water. Contractor to supply required water, free from any organic or chemical contaminants detrimental to humans, animals or healthy plant growth, during planting work and, if required, maintenance work during warranty period.

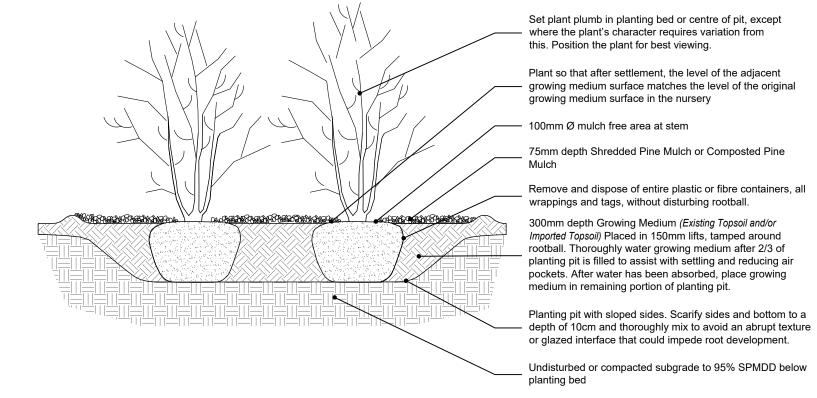

3 TYPICAL SHRUB PLANTING DETAIL - CONTINUOUS BED N.T.S.

Plant Characteristics, Rootballs, Rootball Standards *including minimum rootball diameters*, Harvesting Practices, Transporting, Unloading, Handling/Protection, Scheduling, Water/Irrigation, Digging of Plants and Preparing Roots prior to planting in accordance with the Section 9 of the Canadian Landscape Standard. Do not perform work under adverse field conditions such as frozen soil, excessively wet soil or soil covered with snow, ice, or standing water. Contractor to supply all required water during planting and maintenance work.

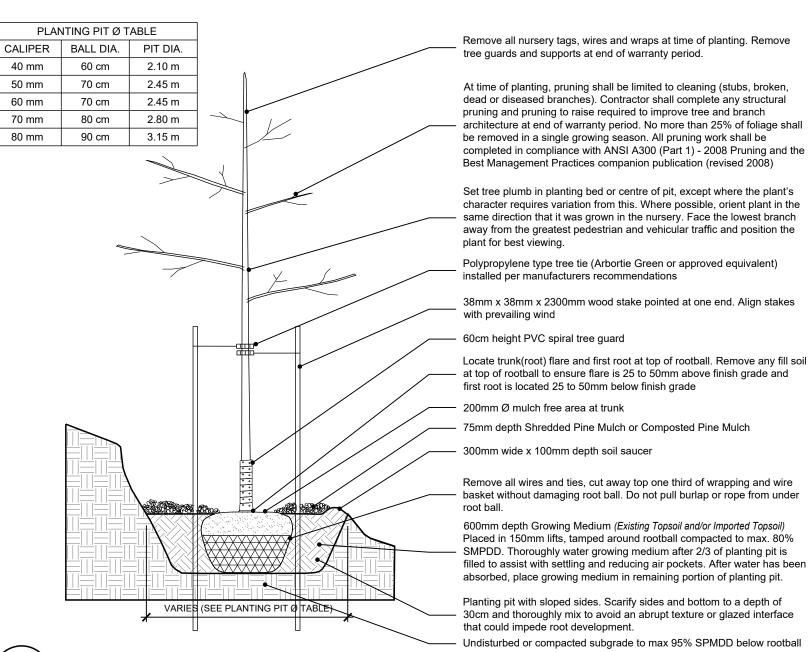

5 TYPICAL DECIDUOUS TREE PLANTING DETAIL - STEEP SLOPES N.T.S.

## PRODUCT SPECIFICATIONS

DESCRIPTION: LUCID BIKE RACK
MODEL #: 462-712

Site Furnishings • Outdoor Fitness


259 Third Concession Rd, PO Box 490
Princeton, ON, NOJ 1V0
Toll-Free: 1-800-387-6318
Phone: (519) 458-4882
Fax: (519) 458-8087
www.peml.com



REVISION:0 DATE: 5/27/2016


Property of Paris Site Furnishings & Outdoor Fitness

6 BIKE RACK DETAIL L2 N.T.S.

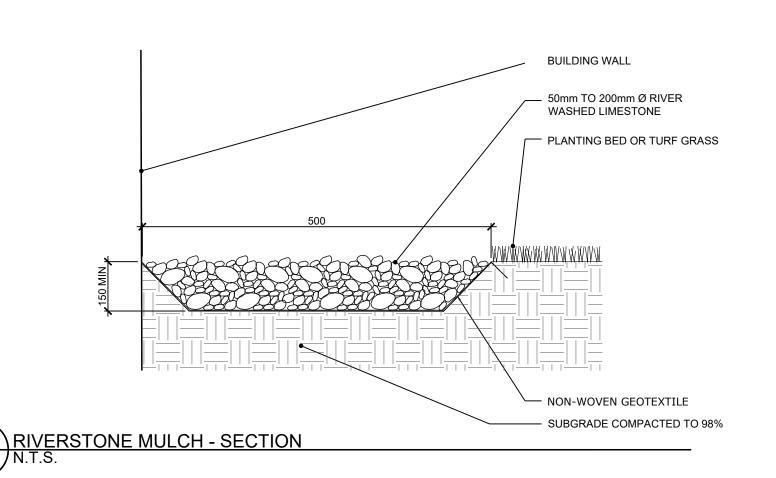



8 \POLY SIGN

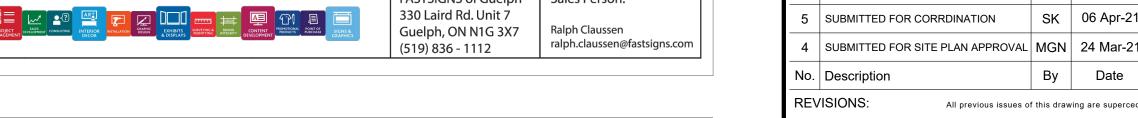

ABOUD & ASSOCIATES INC.
Consulting Arborists • Ecologists • Landscape Architects
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SUBMITTED FOR SITE PLAN APPROVAL | MGN | 10 Aug-21

KEY MAP

## LANDSCAPE DETAILS

roject:

786 WILLIAM ST MIDLAND ONTARIO JENNARK HOMES

| RE-SUBMITTED FOR SPA

SUBMITTED FOR CORRDINATION

Date: NOVEMBER 2020 Designer: SK

Project: AA20-147A Drawn: SK

Scale: AS SHOWN Checked: MGN



∣MGN | 09 Nov-21

SK 06 Aug-21

Drawing No:

**L2**