

$\bigcap$	FIXTURE SCHEDULE									
TYPE	MANUFACTURE	MODEL	CATALOGUE NUMBER	NUMBER AND TYPE OF LAMPS	LAMP COLOR	VOLTAGE	MOUNTING	MOUNTING HEIGHT	REMARKS	ALTERNATE MANUFACTURE
AA	BEACON	VIPER	VPS-36L-80-3K7-4F-UNV-A-BLT-SCP/30F	LED - 80W	3000K	120V	POLE	26'-0" AFG	ARCHITECT TO CONFIRM FINISH. PROVIDE 3'-0" POLE BASE.	
ВВ	BEACON	VIPER	VPS-48L-110-3K7-4F-UNV-A-BLT-SCP/30F-BC	LED - 110W	3000K	120V	POLE	26'-0" AFG	ARCHITECT TO CONFIRM FINISH. PROVIDE 3'-0" POLE BASE.	
СС	BEACON	VIPER	VPS-24L-55-3K7-4W-UNV-A-BLT-SCP/30F-BC	LED - 55W	3000K	120V	POLE	26'-0" AFG	ARCHITECT TO CONFIRM FINISH. PROVIDE 3'-0" POLE BASE.	
DD	BEACON	VIPER	VPS-48L-110-3K7-3-UNV-A-BLT-SCP/30F	LED - 110W	3000K	120V	POLE	26'-0" AFG	ARCHITECT TO CONFIRM FINISH. PROVIDE 3'-0" POLE BASE.	
FF	KIM LIGHTING	WALL DIRECTOR	WDS-D-24L-30-3K7-2-UNV-BL-SCP-20F	LED - 30W	3000K	120V	WALL	16'-0" AFG	ARCHITECT TO CONFIRM FINISH.	
GG	KIM LIGHTING	WALL DIRECTOR	WDS-D-24L-60-3K7-2-UNV-BL-SCP-20F	LED - 60W	3000K	120V	WALL	16'-0" AFG	ARCHITECT TO CONFIRM FINISH.	
НН	PRESCOLITE	LITEISTRY	LTR-6RD-H-SL-15L-DM1-LTR-6RD-T-SL-30K-8-XW-SS	LED - 19W	3000K	120V	RECESSED	N/A	ARCHITECT TO CONFIRM FINISH.	

### Calculation Summary Label CalcType Units Avg Max Min Max/Avg Avg/Min # Points PARKING LOT Illuminance Fc 1.36 3.0 0.3 2.21 4.53 879 PROPERTY LINE Illuminance Fc 0.05 0.3 0.0 6.00 N/A 147

THIS DRAWING INDICATES ALL PROPOSED OUTDOOR
LIGHTING FIXTURES FOR THIS PROPOSED
DEVELOPMENT. THE LIGHTING DESIGN IS IN
ACCORDANCE WITH THE APPLICABLE LIGHTING ZONE AS
ESTABLISHED BY THE TOWN OF MIDLAND, AND DESIGNED
WITH AN AVERAGE TO MINIMUM RATIO IN ACCORDANCE
WITH THE ILLUMINATING ENGINEERING SOCIETY
GUIDELINES. THIS LIGHTING DESIGN WILL NOT CREATE
ANY OBJECTIONABLE GLARE FOR ADJACENT
PROPERTIES.

Signature of Design Professional

#### DISCLAIMER:

CONDUIT TYPES AS NOTED ON DRAWING
 DEVICE MOUNTING HEIGHTS TO BOTTOM OF DEVICES UNLESS OTHERWISE
 NOTED ON PLANS. CONFIRM ALL MOUNTING HEIGHTS WITH ARCHITECTURAL

NOTED ON PLANS. CONFIRM ALL MOUNTING HEIGHTS WITH ARCHITECTURAL PLANS PRIOR TO INSTALLATION. NOTIFY CONSULTANT OF ANY DISCREPANCIES.

#### **GENERAL CONDITIONS:**

- G1 THE CANADIAN STANDARD FORM OF CONSTRUCTION CONTRACT AND GENERAL CONDITIONS GOVERNING THE SAME CCDC ARTICLES 1 TO 45 INCLUSIVE ARE HEREBY MADE A PART OF THIS SPECIFICATION.
- G2 ALL WORK SHALL BE IN FULL ACCORDANCE WITH THE REQUIREMENTS OF THE ONTARIO ELECTRICAL CODE, LOCAL POWER COMMISSION AND THE LOCAL INSPECTION DEPARTMENT REQUIREMENTS.
- G3 ELECTRICAL CONTRACTOR SHALL INCLUDE FOR GENERAL ESA FEES.
  ELECTRICAL CONSULTANT WILL BE RESPONSIBLE FOR ANY ASSOCIATED FEES
  FOR THE FSA PLAN REVIEW
- FOR THE ESA PLAN REVIEW.

  G4 THIS CONTRACTOR SHALL MAINTAIN ADEQUATE LIABILITY INSURANCE.
- G5 ALL WORKMANSHIP SHALL BE EXECUTED TO A STANDARD DETERMINED BY GOOD PRACTICE. THE ELECTRICAL CONTRACTOR SHALL GUARANTEE THE INSTALLATION FOR ONE YEAR.
- THE ELECTRICAL CONTRACTOR SHALL SUBMIT SIX (6) SETS OF SHOP DRAWINGS TO THE ENGINEER. MATERIALS SHALL NOT BE ORDERED UNTIL REVIEW HAS BEEN COMPLETED. APPROVAL IS FOR GENERAL DESIGN AND ARRANGEMENT
- G7 THE OWNERS RESERVE THE RIGHT TO ALTER THE LOCATION OF ANY ITEM UP TO TEN (10) FEET (3M) WITHOUT INCURRING AN EXTRA COST, PROVIDED HE DOES SO BEFORE THE ITEM IS INSTALLED.
- G8 ALL MATERIAL AND EQUIPMENT USED ON THIS PROJECT SHALL BE C.S.A.
- G9 THE CUTTING AND PATCHING FOR ELECTRICAL WORK SHALL BE DONE BY THE GENERAL CONTRACTOR AT THE ELECTRICAL CONTRACTOR'S EXPENSE.
- G10) THE ELECTRICAL CONTRACTOR SHALL VISIT THE SITE TO FAMILIARIZE HIMSELF
- WITH THE EXISTING CONDITIONS BEFORE SUBMITTING HIS TENDER PRICE.

  G11 ALL DIMENSIONS SHALL BE TAKEN FROM THE ARCHITECTURAL DRAWINGS.
- THE ELECTRICAL CONTRACTOR SHALL SUPPLY ALL LABOUR AND MATERIALS TO PROVIDE ELECTRIC SERVICE COMPLETE WITH BRANCH CIRCUITS ALL AS SHOWN
- G13 PROVIDE LABELING OF ALL ELECTRICAL DEVICES AND EQUIPMENT.
- G14 ELECTRICAL CONTRACTOR SHALL NOTIFY ELECTRICAL CONSULTANT OF ANY DISCREPANCIES RELATED TO THE ELECTRICAL DRAWINGS DURING THE TIME OF TENDER

<u> </u>	POLE LENGTH (ft.) 10 19 23	BASE BURIAL DEPTH D (ft.) 5	REINF. ROD LENGTH (ft.) H+4.5 H+6.5 H+6.5	③ CLASS OF CON	ATION SHALL BE MOOTH & LEVEL. CRETE SHALL BI ALL BE VIBRATE VO SLEEVES RE C. FOUNDATION	E E 3000 P.S.I. D. QUIRED	IN POL CONDU (7) SUBJE TO SOI (8) FORM FACTO	RVED  RACTOR TO VERIFY OPENING SIZE E BASE PLATE PRIOR TO SETTING JIT SLEEVES. CT TO SOIL CONDITIONS, REFER IL REPORT. RELEASE AGENT HAS BEEN IRY-APPLIED TO INSIDE SURFACE FORM".
	25 29 30 35  PROVIDE A BL OPTIONAL ALL COLOR ACCEN	JMINUM —	H + 6.5 H + 7.5 H + 7.5 H + 8.0	12"	20" Dia 18" Dia		CA NE	GHTING POLE OLE BASE COVER OCK NUTS EVELING NUTS  AST-IN-PLACE ARCHITECTURAL DNCRETE BASE BY MEANS OF EWAVEA 510R-HIGH STYLE SINGLE-USE HFORMS CONCRETE FORM JPPLIED BY: EFORMS INTERNATIONAL INC. EL. 905-642-3225
s	FIN. GRADE —	, N					G.	ww.ArtFORMSConcreteBases.com  ALVANIZED STEEL "J" BOLTS S SUPPLIED BY MANUFACTURER
		(KEFEK LONOLE 7) FIBER FORM	36"		3" MIN. CC	OVER	FI 2" SI	OP OF CONVENTIONAL BER FORM AT 2" BELOW FIN. GRADE  RIGID PVC CONDUIT LEEVE 36" RADIUS REFER TO ELECTRICAL)
O N		D (KEFF				4	F0 R D	.75" RIGID CONDUIT SLEEVE OR GROUND CONNECTION AS EQUIRED & SPECIFIED-SEE WGS. (REFER TO NOTE 5) -#6 REINF. RODS & #4 TIES
F	POLYETHYLE (REFER TO EL				18" Dia.			
<u> </u>	F	ADAPT RIGID POLYETHYLE COUPLING (F	NE PIPE WI	TH ADAPTER LECTRICAL).				

# ELECTRICAL LEGEND SYMBOL DESCRIPTION MTD. HEIGHT AS NOTED POLE MOUNTED FIXTURE POLE MOUNTED FIXTURE (BACK TO BACK) AS NOTED WALL MOUNTED FIXTURE AS NOTED BOLLARD FIXTURE N/A NOTE TAG N/A

#### CONDUIT LEGEND + CONVERSION

SYMBOL	METRIC	IMPERIAL
- " - 16mm - " - 16mm - " - 16mm - " - 16mm	16mm	<u>1</u> "
— " — 21mm — " — 21mm — " — 21mm — " — 21mm	21mm	<u>3</u> " 4
- " - 27mm - " - 27mm - " - 27mm - 27mm 27mm	27mm	1"
- " - 35mm - " - 35mm - " - 35mm - " - 35mm	35mm	1- <del>1</del> "
- " - 40mm - 40	40mm	1- <del>1</del> "
— - — 50mm	50mm	2"
— - — 75mm — - — 75mm — 75mm — 75mm — 75mm — 75mm —	75mm	3"
" — 100mm — " — 100mm — " — 100mm	100mm	4"

#### CONDUIT + TRAY TYPES

<u>U/G</u> 100mm 100mm 100mm	UNDERGROUND CONDUIT (SIZE AS PER PL
O/H " — 100mm — " — 100mm — " — 100mm	OVERHEAD CONDUIT (SIZE AS PER PLAN)
Ð	CONDUIT STUB DOWN
•	CONDUIT STUB UP

#### **ELECTRICAL SITE PLAN NOTES:**

 $\left\langle P1\right\rangle$  ELECTRICAL CONTRACTOR SHALL PROVIDE BASE FOR POLE MOUNTED FIXTURE AS PER DETAIL 1 ON SHEET ES.3.

P2 ELECTRICAL CONTRACTOR SHALL PROVIDE BASE FOR BOLLARD FIXTURE AS PER DETAIL 2 ON SHEET ES.3.4

(1)	POLE BASE DETAILS FOR POLE MOUNTED FIXTURES (36")
ES.2	NTS



CONSULTANT STAMP:

11/12/21

786 William St Apartment
786 WILLIAM ST.
MIDLAND, ON

DRAWING TITE


20-216

CONSULTANT

## ELECTRICAL SITE PLAN NOTES & DETAILS


DRAWN BY:	CHECKED	BY:	APPROVED BY:	
M. TAYLOR D. SARG		ENT	D. SARGENT	
SCALE: AS NOTED		SHEET SIZE: ARCH D		
PROJECT #:		SHEET #:		


ES.2

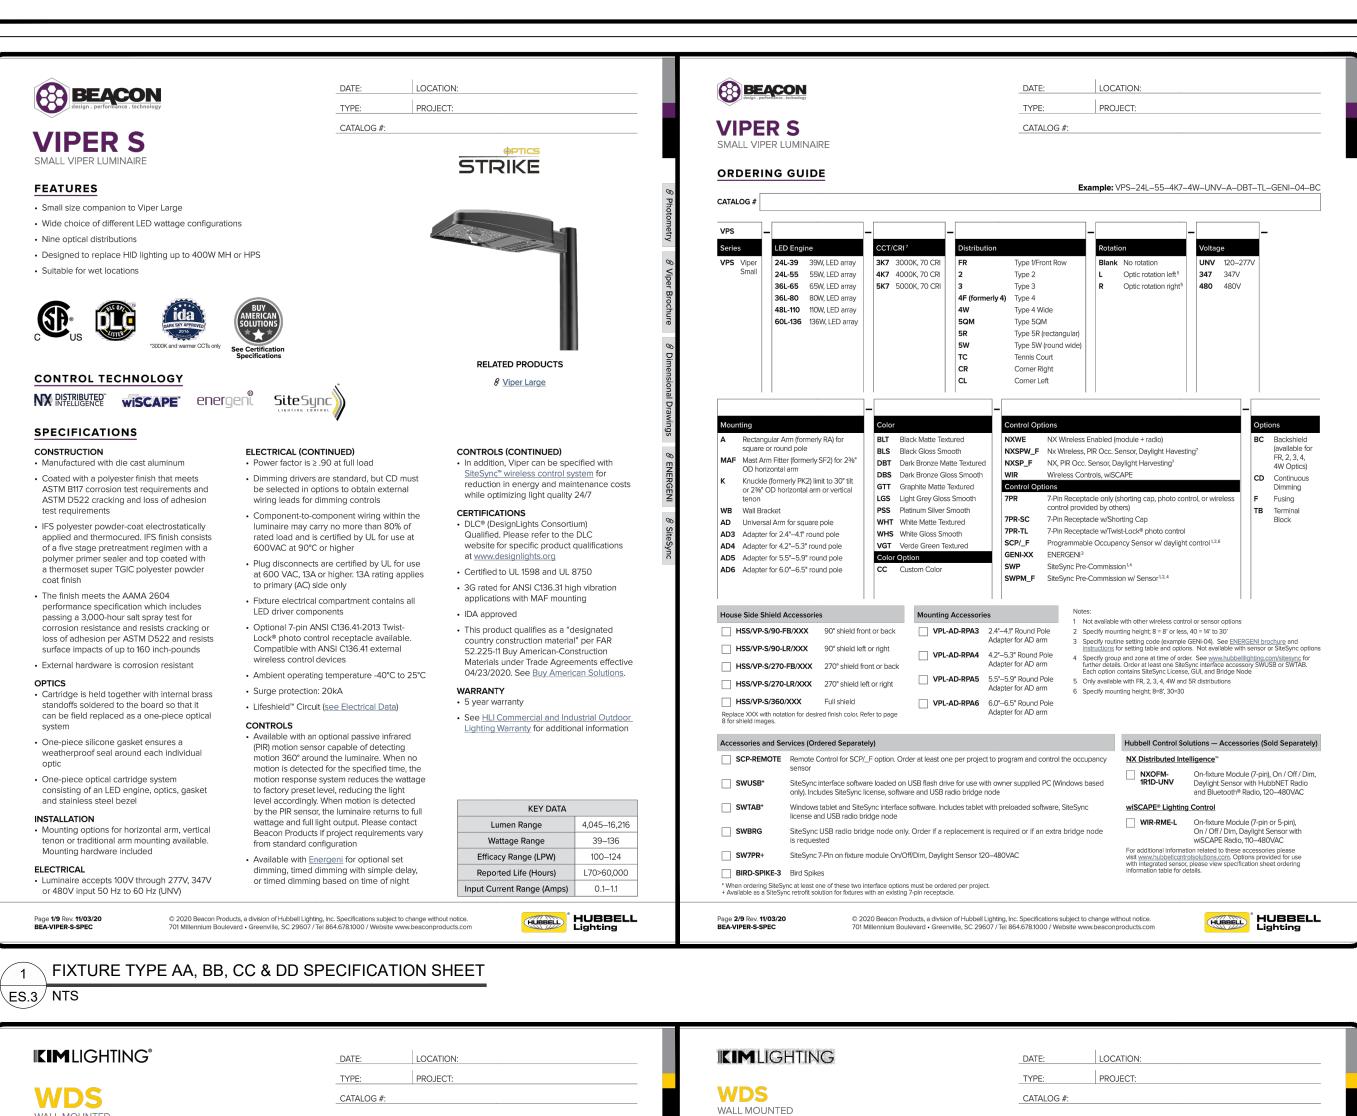

ES.3 NTS


ES.3 NTS

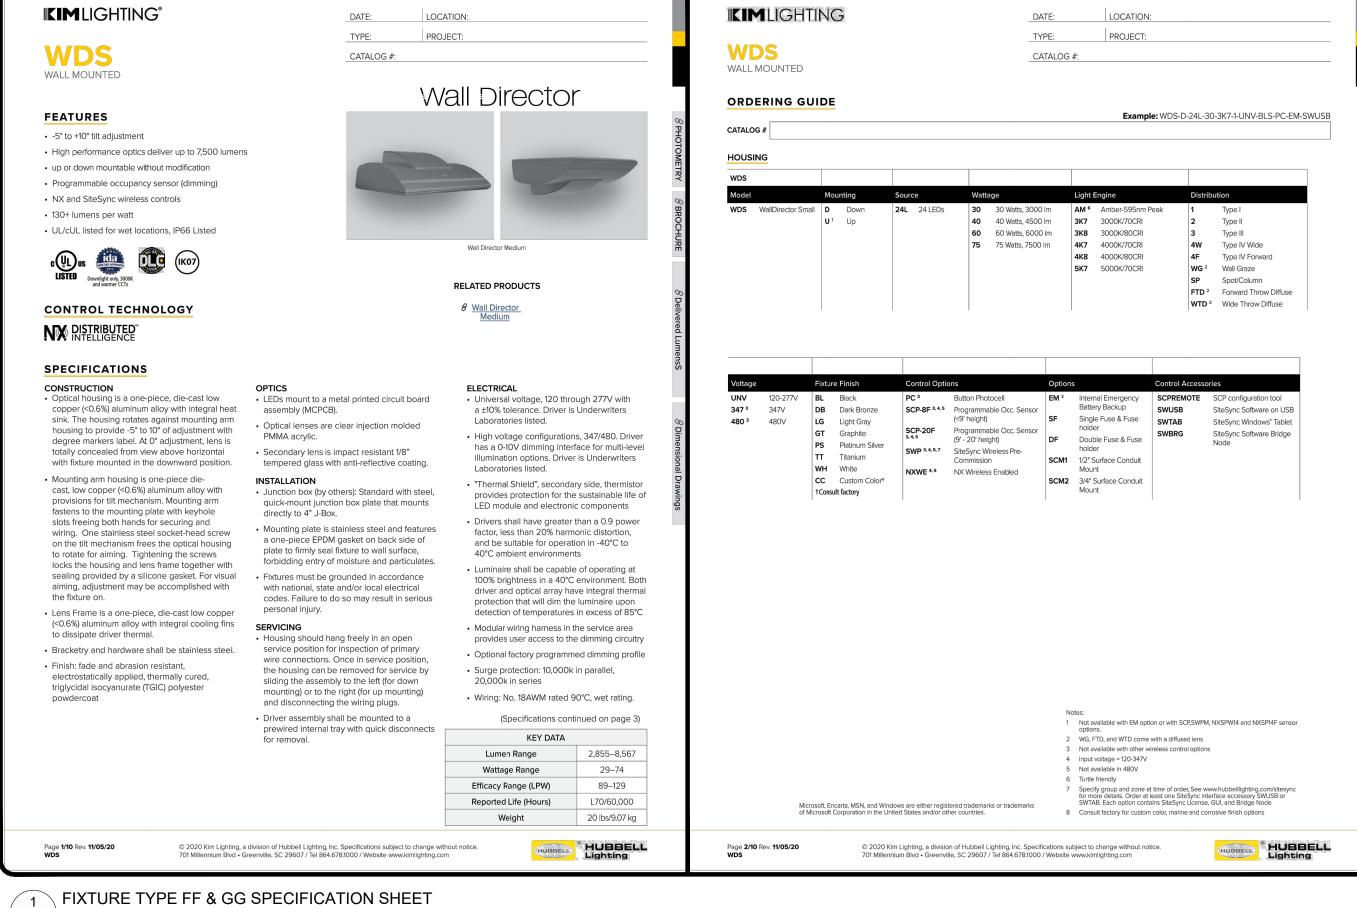

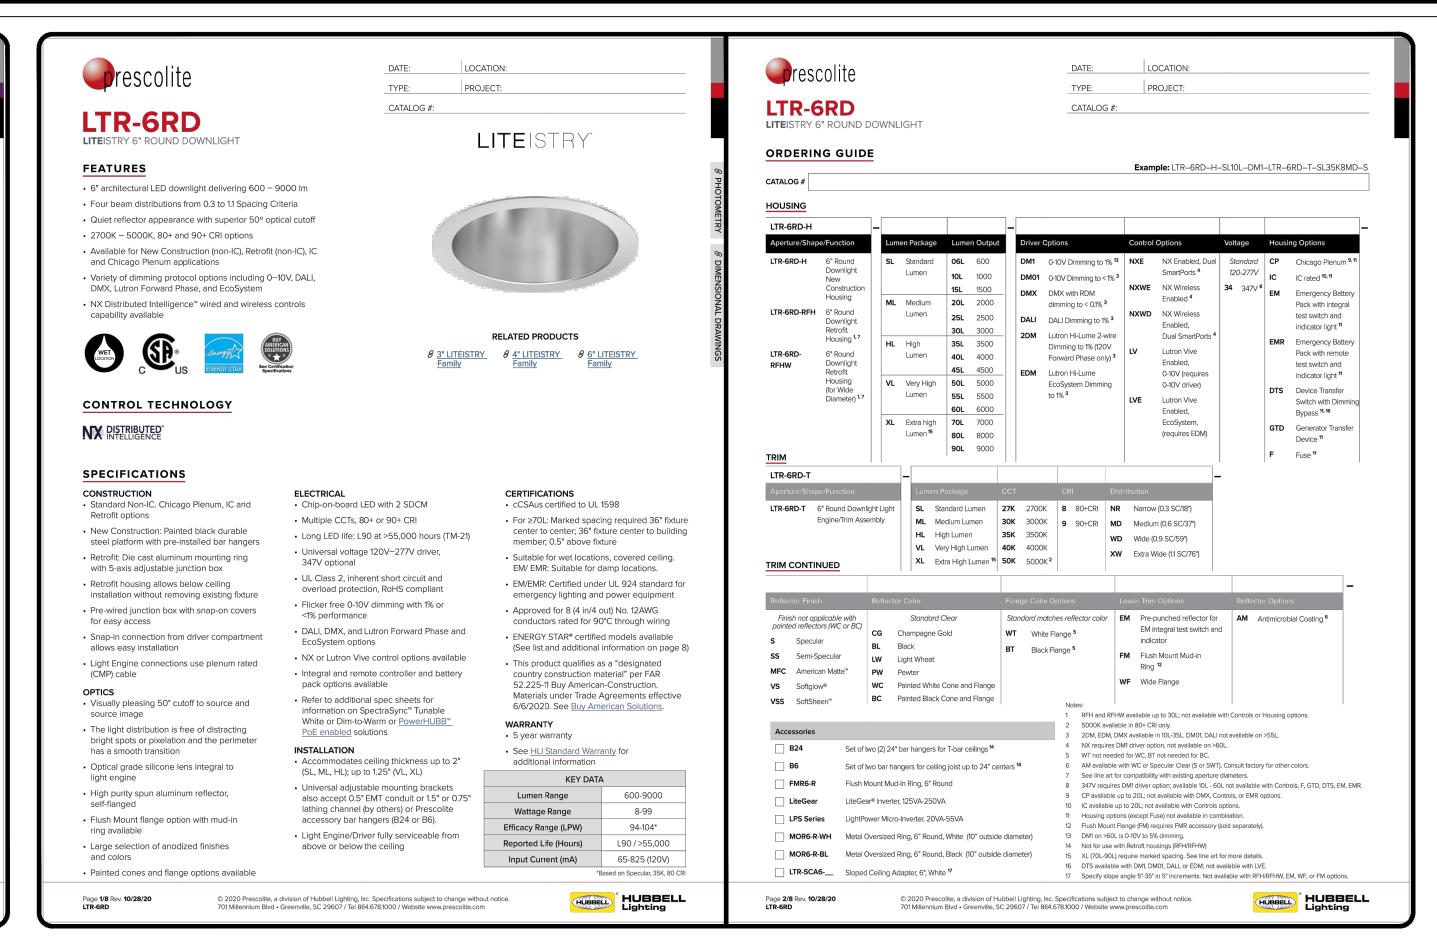

FIXTURE TYPE JJ SPECIFICATION SHEET

ES.3/ NTS

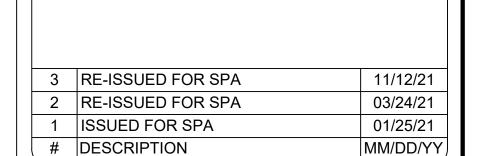

CONSULTANT

NORTH:

CONSULTANT STAMP:

11/12/21

786 William St Apartment 786 WILLIAM ST. MIDLAND, ON

ELECTRICAL SITE PLAN NOTES & DETAILS

20-216		ES.3		
PROJECT #:		SHEET #:		
SCALE: AS NOTED		ARCH D		
M. TAYLOR	D. SARGENT		D. SARGENT	
DRAWN BY:	CHECKED BY:		APPROVED BY:	